


This drawing is the property of low carbon power and should not be reproduced, stored in a retrieval system, or transmitted in any form or by any means, electronic, mechanical, photocopying, recording, or by any information storage and retrieval system, without the prior written permission of low carbon power. Scaled dimensions must not be taken from this drawing. All dimensions are to be confirmed on site prior to commencement of work.

Revision	Date	Revisions/Notes	Drawn	Inspected
01	23.07.20	First Issue	HN	IL
02	16.08.20	Revised	HN	IL


NOTES:

NB: DNO cabin dimensions will vary, dependant on network operator design requirements, selected at the detailed design stage. Measurements are indicative only.

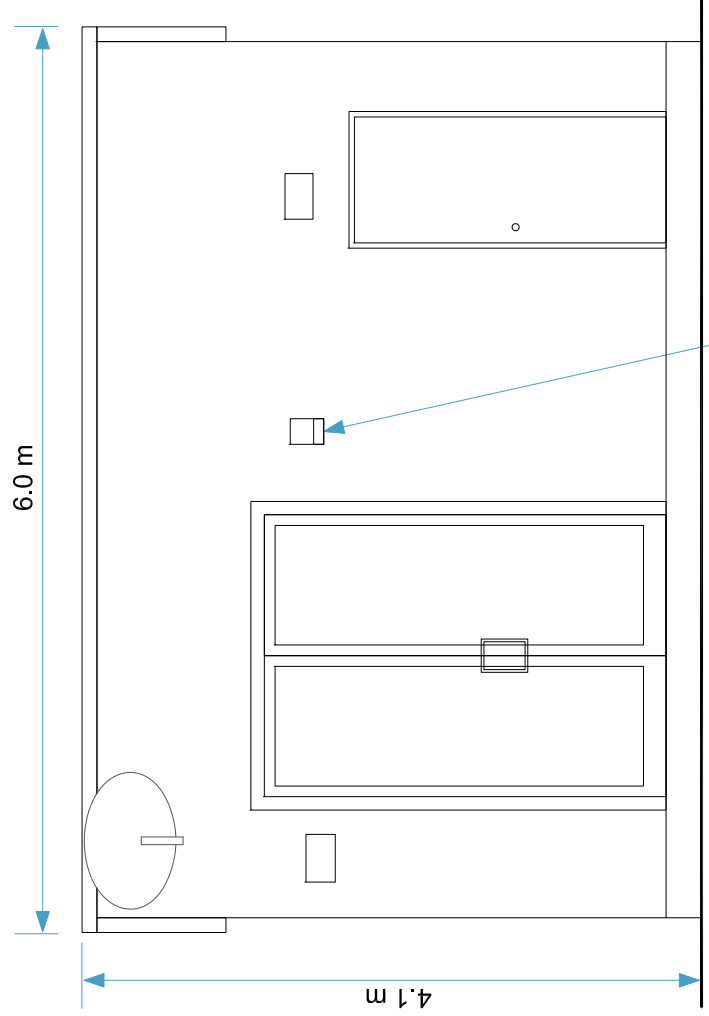


Front Elevation


Bulk Head Light

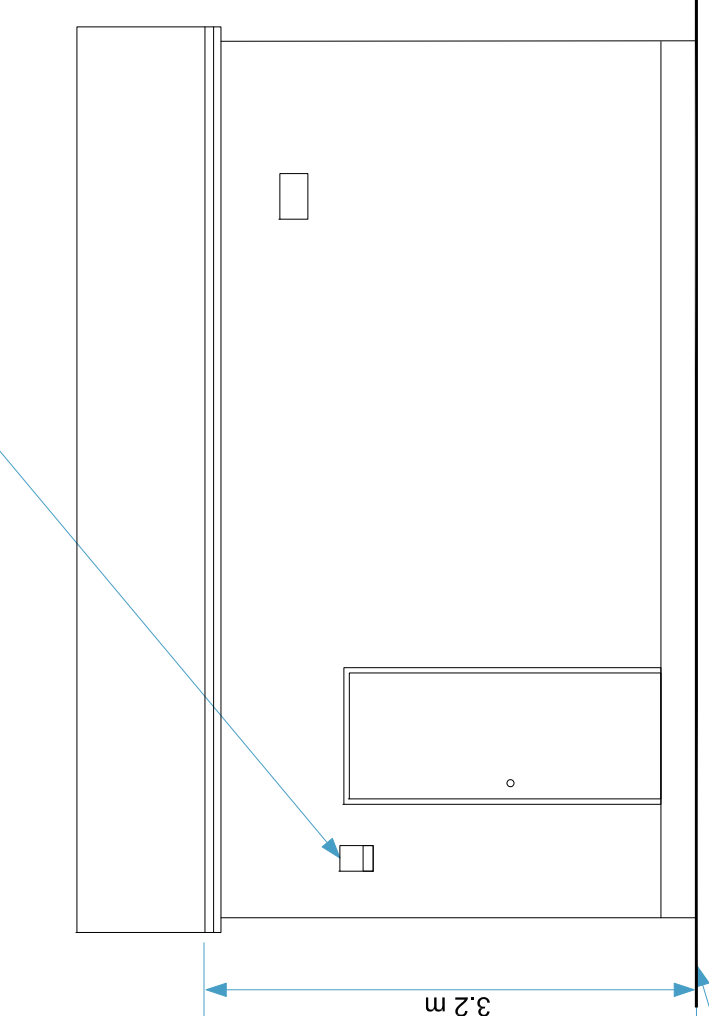

Rear Elevation

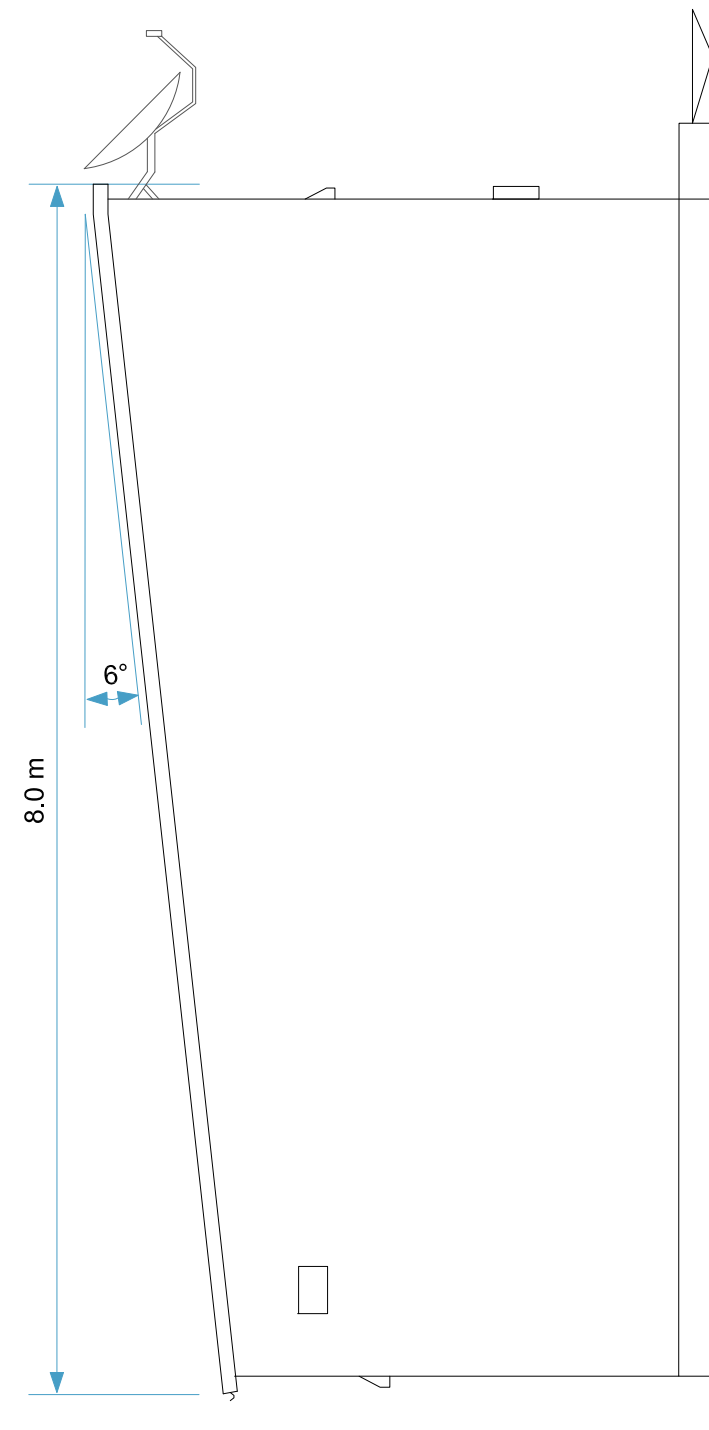

Left Elevation

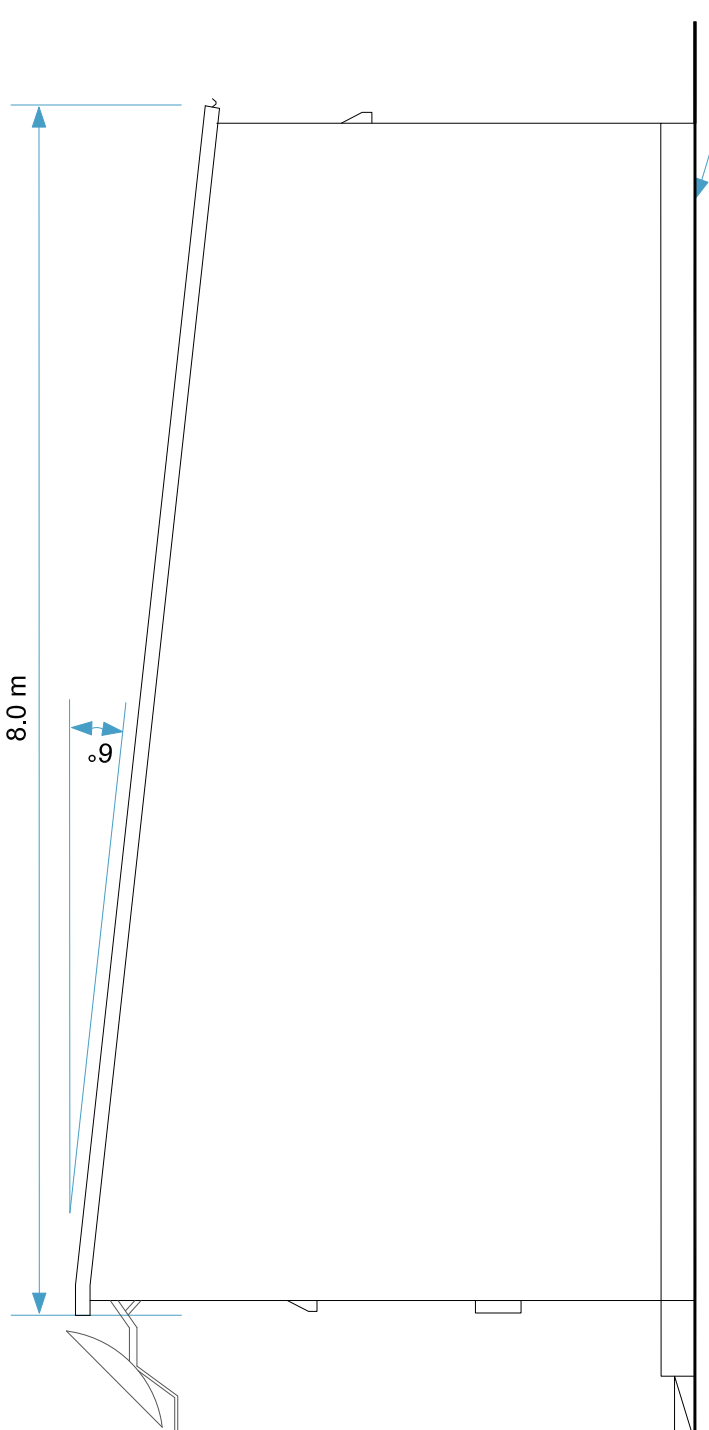

Right Elevation

Status: FOR PLANNING



13 Berkeley Street, London W1J 8GU
Tel: +44(0)207 4006700
enquiries@lowcarbon.com www.lowcarbon.com

Drawing Title: DNO Substation Elevations and Dimensions Plan

Drawn: HN	Checked: IL	First Issued: 23.07.2020
Project Code: LCS-	Drawing Number: SD-01	Revision: 02
Sheet Size: A3	Scale: 1:50	

